#### **AUDIO/VISUAL**

ΔR	<b>BRE</b> \	/ΙΔΤΙ	ONS
70		,,,,,,,,,,,,,,,,,,,,,,,,,,,,,,,,,,,,,,,	0110

ACT	ACOUSTICAL CEILING TILE
AFC	ABOVE FINISHED CEILING
AFF	ABOVE FINISHED FLOOR
AFG	ABOVE FINISHED GRADE
ANSI	AMERICAN NATIONAL STANDARDS INSTITUTE
ATC	AUTOMATIC TEMPERATURE CONTROL
ATM	ASYNCHRONOUS TRANSFER MODE
AWG	AMERICAN WIRE GAUGE
BFC	BELOW FINISHED CEILING
BFF	BELOW FINISHED FLOOR
BFG	BELOW FINISHED GRADE

ACR ATTENUATION CROSSTALK RATIO

CATEGORY (TIA/EIA) CAT CKT CIRCUIT CLK CM CLOCK CORD MANAGER

COMMUNICATIONS RISER RATED COMMUNICATIONS PLENUM RATED CONSOLIDATION POINT CUSTOMER PREMISE EQUIPMENT CPE DIA DPDT DIAMETER

DOUBLE POLE, DOUBLE THROW DRAWING ELECTRICAL CONTRACTOR ENTRANCE FACILITY ELECTRONICS INDUSTRIES ASSOCIATION ELFEXT EQUAL LEVEL FAR-END CROSSTALK ELECTROMAGNETIC INTERFERENCE ELECTRICAL METALLIC TUBING EXPLOSION PROOF

EQUIPMENT ROOM FEDERAL COMMUNICATIONS COMMISSION FIBER OPTIC PATCH PANEL FIBERGLASS REINFORCED POLYESTER FTP FOIL TWISTED PAIR

GENERAL CONTRACTOR GROUND HORIZONTAL CROSSCONNECT HEATING CONTRACTOR HVAC HEATING, VENTILATION AND AIR CONDITIONING

INTERMEDIATE CROSSCONNECT INSIDE DIAMETER INSULATION DISPLACEMENT CONNECTOR INTERMEDIATE DISTRIBUTION FRAME INSTITUTE OF ELECTRICAL AND ELECTRONIC ENGINEERS INTEGRATED SERVICES DIGITAL NETWORK

INTERNATIONAL STANDARDS ORGANIZATION INTERMEDIATE METAL CONDUIT KEY SYSTEM UNIT

MAXIMUM MEGA-BITS PER SECOND MAIN CROSSCONNECT MECHANICAL CONTRACTOR MAIN DISTRIBUTION FRAME MANUFACTURER MEGA-HERTZ MICRON

MINIMUM MTD MOUNTED NORMALLY CLOSED NORMAL EMERGENCY NO. NUMBER

NORMALLY OPEN NATIONAL ELECTRIC CODE NEAR-END CROSSTALK NATIONAL FIRE PROTECTION ASSOCIATION NFPA OUTSIDE DIAMETER

PRIVATE BRANCH EXCHANGE PERSONAL COMPUTER PLUMBING CONTRACTOR POWER FAILURE TELEPHONE PNL

POINT OF PRESENCE

PATCH PANEL PSI POUNDS PER SQUARE INCH PUBLIC SWITCHED TELEPHONE NETWORK PVC POLYVINYL CHLORIDE

QTY

RADIO FREQUENCY RIGID GALVANIZED STEEL RMS RACK MOUNT SPACE

SUBSCRIBER CONNECTOR SECURITY CONTRACTOR SCREENED TWISTED PAIR STRAIGHT TIP FIBER CONNECTOR STP SHIELDED TWISTED PAIR

TELECOMMUNICATION BONDING BACKBONE TBBIBC TELECOMMUNICATION BONDING BACKBONE INTERCONNECTING BONDING CONDUCTOR -OR (GE) GROUNDING EQUALIZER TELECOMMUNICATION BONDING

TELECOMMUNICATIONS CLOSET TELECOMMUNICATION GROUNDING BUSBAR TELECOMMUNICATIONS INDUSTRY ASSOCIATION TELECOMMUNICATION MAIN GROUNDING

TELECOMMUNICATIONS OUTLET TRANSITION POINT TYP TYPICAL

UNDERWRITERS LABORATORIES UNINTERRUPTIBLE POWER SUPPLY UNSHIELDED TWISTED PAIR

VOLTS, ALTERNATING CURRENT VIRTUAL LOCAL AREA NETWORK

XCEIVER TRANSCEIVER

WIDE AREA NETWORK WORK AREA OUTLET WALL MOUNTED FIBER PATCH PANEL WEATHERPROOF XFMR TRANSFORMER

#### **AUDIO VISUAL**

P	CEILING	PROJECTOR (CEILING)
12:00	-	CLOCK RECEPTACLE
	_	CLOCK\SOUND SYSTEM SPEAKER COMBO
©	-	INTERCOM JACK
$\bigcirc lacktriangle$	FLOOR	KEYED VOLUME AND POWER
M	FLOOR	FLOOR MOUNTED MICROPHONE JACK
(\$)	CEILING	CEILING MOUNTED SPEAKER
<u>\$</u>	18" AFF	SPEAKER RECEPTACLE
H⊲ <sup>WP</sup>	AS NOTED	EXTERIOR PAGING HORN
H⊲	AS NOTED	INTERIOR PAGING HORN
	CEILING	PROJECTOR OUTLET
RCP	-	REMOTE CONTROL PANEL
S	AS NOTED	SIREN
S	18" BFC	REMOTE SOUND SYSTEM CEILING MOUNTED SPEAKER
S	18" BFC	REMOTE SOUND SYSTEM LEFT CHANNEL STEREO SPEAKER
S	18" BFC	REMOTE SOUND SYSTEM MAIN SPEAKER
SR	18" BFC	REMOTE SOUND SYSTEM RIGHT CHANNEL STEREO SPEAKER
SSUB	AS NOTED	REMOTE SOUND SYSTEM SUBWOOFER
4	_	TSR JACK
	18" AFF	WALL-MOUNTED MICROPHONE JACK
V	48" AFF	REMOTE VOLUME CONTROL

#### TYPICAL ANNOTATION

	CLOUD
$\hat{\mathbf{x}}$	REVISION
(xx)	CIRCLE KEYNOTE
X	DEMOLITION KEYNOTE
$\langle \overline{XX} \rangle$	EQUIPMENT TAG-COMPLEX

EQUIPMENT TAG-SIMPLE

### TELECOMMUNICATIONS GENERAL NOTES

- CONTRACTOR/CONSTRUCTION MANAGER AND OTHER TRADES TO PROVIDE AND/OR ALTER SYSTEMS AS REQUIRED BY THE DRAWINGS AND/OR SPECIFICATIONS.
- 2. CONTRACTOR SHALL REPLACE IN-KIND ALL CEILING TILE DAMAGED DURING INSTALLATION AT NO ADDITIONAL COST.
- 3. CONTRACTOR SHALL REPAINT AND/OR REPAIR ANY AREA IN-KIND IF INSTALLATION DEFACES EXISTING WALLS, FLOORS OR CEILINGS PAINTED AREAS.
- CABLES, ETC. IT IS THE CONTRACTORS RESPONSIBILITY TO PROVIDE IN HIS BID PRICE, ALL APPURTENANCES FOR A COMPLETE AND OPERATIONAL SYSTEM THAT MEETS THE SYSTEM DESIGN REQUIREMENTS, WHETHER OR NOT SHOWN ON THE DRAWINGS OR CALLED OUT IN THE
- 5. ALL ELECTRICAL RECEPTACLES SHOWN ARE FOR INFORMATIONAL PURPOSE ONLY. ALL ELECTRICAL
- 7. ALL COMMUNICATIONS DATA, VIDEO AND VOICE CABLES INSTALLED ON THIS PROJECT SHALL BE SUPPORTED WITH CABLE TRAY, CONDUIT AND J-HOOKS, AS CALLED OUT ON THE DRAWINGS AND IN SPECIFICATIONS. FURNISH AND INSTALL ALL REQUIRED CABLE SUPPORTS AND APPURTENANCES
- 9. AT A.D.A. LOCATIONS CONTRACTOR SHALL CONFORM TO ALL LOCAL, STATE AND NATIONAL CODES.
- 10. THE CONTRACTOR SHALL REVIEW ALL DRAWINGS BEFORE BIDDING. FAILURE TO DO SO WILL NOT BE JUST CAUSE FOR A CHANGE REQUEST.
- 12. COORDINATE WITH E.C. FOR ADDITIONAL 1" CONDUIT STUB-UPS FROM ANY LOCATION THAT
- 13. NO BRIDLE RINGS, 'LB-FITTING', OR PLASTIC WIRE TIES SHALL BE USED.

#### 1. THE CONTRACTOR IS RESPONSIBLE FOR INTERFACING WITH THE GENERAL

- 4. THESE DRAWINGS MAY NOT SHOW ALL REQUIRED CONNECTIONS, PATCH CORDS, INTERCONNECTING
- RECEPTACLES ARE BY E.C.
- 6. ALL STATION JACKS, DROPS, CABLES, AND PATCH PANELS SHALL BE LABELED/IDENTIFIED TO MEET THE EIA-TIA/606 LABELING REQUIREMENTS. THE CONTRACTOR IS REQUIRED TO SUBMIT A LABELING SCHEME AND SCHEDULE FORMAT FOR APPROVAL BY THE ENGINEER AND OWNER.
- FOR A COMPLETE AND FUNCTIONAL SYSTEM.
- 8. FIELD LOCATE SPEAKERS TO AVOID ANY LIGHTING/HVAC INTERFERENCES.
- 11. ALL SYSTEM WIRING INSTALLED ON THIS PROJECT SHALL BE SUPPORTED WITH CONDUIT STUBS AND J-HOOKS AT INTERVALS OF 4'-0" MAXIMUM. FURNISH AND INSTALL ALL REQUIRED CABLE SUPPORTS AND APPURTENANCES FOR A COMPLETE AND FUNCTIONAL SYSTEM.
- CONTAIN OVER 6 COMMUNICATIONS CABLES.

DRAWING LIST		
SHEET NUMBER	DRAWING TITLE	
AV-0	SYMBOLS, LEGENDS AND ABBREVIATIONS — AUDIO / VIDEO	
AV-1	LARGE MEETING ROOM 128 - PLANS - AUDIO / VIDEO	
AV-2	LARGE MEETING ROOM 128 - RISERS - AUDIO / VIDEO	
AV-3	LARGE MEETING ROOM 128 - DETAILS - AUDIO / VIDEO	
AV-4	SMALL MEETING ROOM 118 - PLANS AND DETAILS - AUDIO / VIDEO	
AV-5	FIRST FLOOR PLAN - PUBLIC ADDRESS	
AV-6	SECOND FLOOR PLAN - PUBLIC ADDRESS	
AV-7	RISER DIAGRAM & DETAILS — PUBLIC ADDRESS	

CONSTR	UCTION REFERENCE DRAWINGS LIST
SHEET NUMBER	DRAWING TITLE
T-0.1	SYMBOLS, LEGENDS AND ABBREVIATIONS — TELECOM
T-2.1	FIRST FLOOR PLAN - TELECOM
T-2.2	SECOND FLOOR PLAN — TELECOM
T-3.01	ENLARGED PLANS — TELECOM
T-4.01	ELEVATION DETAILS — TELECOM
T-5.01	RISER DIAGRAM — TELECOM
T-7.01	DETAILS — TELECOM
T-7.02	DETAILS — TELECOM
T-7.03	DETAILS — TELECOM
T-7.04	DETAILS — TELECOM
E-0.1	SYMBOLS, LEGENDS, AND ABBREVIATIONS — ELECTRICAL
E-1.1	FIRST FLOOR PLAN - DEMOLITION - ELECTRICAL
E-1.2	SECOND FLOOR PLAN — DEMOLITION — ELECTRICAL
E-2.1	FIRST FLOOR PLAN - NEW WORK - ELECTRICAL
E-2.2	SECOND FLOOR PLAN - NEW WORK - ELECTRICAL
E-2.4	LARGE SCALE PLANS - ELECTRICAL
E-3.1	FIRST FLOOR PLAN - NEW WORK - LIGHTING
E-3.2	SECOND FLOOR PLAN - NEW WORK - LIGHTING
E-4.1	RISER DIAGRAM — ELECTRICAL
E-5.1	DETAILS — ELECTRICAL
E-5.2	DETAILS — ELECTRICAL
E-6.0	LIGHTING FIXTURE SCHEDULE - LIGHTING
E-6.1	PANEL SCHEDULES — ELECTRICAL
E-6.2	PANEL SCHEDULES — ELECTRICAL
i	

10521 Rosehaven Street, Suite 200 Fairfax, VA 22030 Phone 703-691-3311 Fax 703-691-3316



Phone: (717) 233-4502

Fax: (717) 233-0833

www.brinjac.com

Loudoun County Public Library Gum Spring Branch

Loudoun County, Virginia

SYMBOLS, LEGENDS, AND ABBREVIATIONS -**AUDIO / VIDEO** 

Sheet Number:

CONTRACTOR SHALL CHECK & VERIFY ALL DIMENSIONS &

EXISTING CONDITIONS AT SITE.

AV-0

Issue Date: 05/01/2012 Project Manager: PMW Drafter: NPD

### III SAMAHA

10521 Rosehaven Street, Suite 200 Fairfax, VA 22030

Fax 703-691-3316

Phone 703-691-3311

114 North 2nd Street Harrisburg, PA 17101-1401

Phone: (717) 233-4502 Fax: (717) 233-0833 www.brinjac.com

COORDINATION WITH ON-SITE

ELECTRICAL CONTRACTOR

ELECTRICAL CONTRACTOR.

CONDUIT, PATHWAYS, AND BACKBOXES ARE PROVIDED BY THE ON-SITE

BEFORE ROUGH-IN THE AV CONTRACTOR SHALL MEET WITH THE ON-SITE

ELECTRICAL CONTRACTOR TO REVIEW, FIELD VERIFY AND ADJUST AS REQUIRED ALL CONDUIT, PATHWAYS, AND BACKBOXES. AV CONTRACTOR SHALL SUBMIT LETTER OF COMPLETION AS A SHOP DRAWING TO THE ENGINEER.

#### **GENERAL NOTES:**


- AV CONTRACTOR SHALL PROVIDE A PROJECTION SYSTEM (PROJECTOR, LENS, MOUNT, SCREEN) THAT WORKS TOGETHER. THROW DISTANCE AND ASPECT RATIOS SHALL BE COORDINATED.
- ALL CABLES SHALL BE PLENUM RATED OR RUN IN EMT CONDUIT.

#### **KEYED NOTES:**

- THE TOP EDGE OF THE SCREEN IMAGE SHALL BE BELOW THE PENDANT LIGHT FIXTURES. PROVIDE BLACK MASKING AS REQUIRED. THE BOTTOM EDGE OF THE SCREEN IMAGE SHALL BE BETWEEN 40" AND 48" AFF. CENTER SCREEN LEFT AND RIGHT WITH THE DROP CEILING CLOUD.
- 2 PROVIDE PIPE EXTENSION AS REQUIRED TO LOWER PROJECTOR BELOW PENDANT LIGHTING
- 3 120 VAC RECEPTACLE POWER. FOR REFERENCE ONLY. SEE ELECTRICAL DRAWINGS.


AND AVOID KEYSTONING.

- 4 LIGHTING CONTROLS. FOR REFERENCE ONLY. SEE ELECTRICAL DRAWINGS.
- 5 MOTORIZED PROJECTION SCREEN SHALL BE CARFULLY LOCATED WITH RECESSED DOWN LIGHTING IN THIS AREA.
- 6 PROVIDE (4) BALANCED MICROPHONE XLR CONNECTIONS IN THIS FLOOR BOX. MICROPHONE CABLES SHALL NOT SHARE CONDUIT WITH ANY OTHER CABLE.
- 7 SURFACE MOUNTED STEREO SPEAKERS.
  SUPPORT PER DETAIL. JUNCTION BOX TO BE
  LOCATED 1' OUTSIDE OF THE SCREEN AND
  94" AFF. SPEAKERS SHALL BE TILTED DOWN
  3 DEGREES. PROVIDE GROMMETED PLATE
  DISCRETELY HIDDEN BEHIND SPEAKER.
  (TYPICAL OF 2)
- 8 PROVIDE EQUIPMENT STRUCTURAL SUPPORT PER MANUFACTURER RECOMMENDATIONS.
- 9 LOCATION OF ABOVE CEILING ELECTRICAL JUNCTION BOX. FOR REFERENCE ONLY. SEE ELECTRICAL DRAWINGS.
- 10 PROVIDE AV LOW LAPTOP INPUT PLATE PER DETAIL. PROVIDE 3—GANG DECORA FACE PLATE TO MATCH OTHER DEVICE FINISHES IN THE SPACE. (TYPICAL OF 2)
- 11) SHADE CONTROLS. FOR REFERENCE ONLY. SEE ELECTRICAL DRAWINGS.
- PROVIDE MOTORIZED PROJECTION SCREEN OVERRIDE KEYPAD PER THE SPECIFICATIONS. PROVIDE CABLING TO CONTROLLER.
- PROVIDE IN WALL DOCKING STATION FOR WIRELESS TOUCH PANEL PER THE SPECIFICATIONS.
- 14) IN WALL DEVICES SHALL BE FLUSH. TOP EDGE OF DEVICES SHALL BE IN LINE AND NO HIGHER THAN 48".

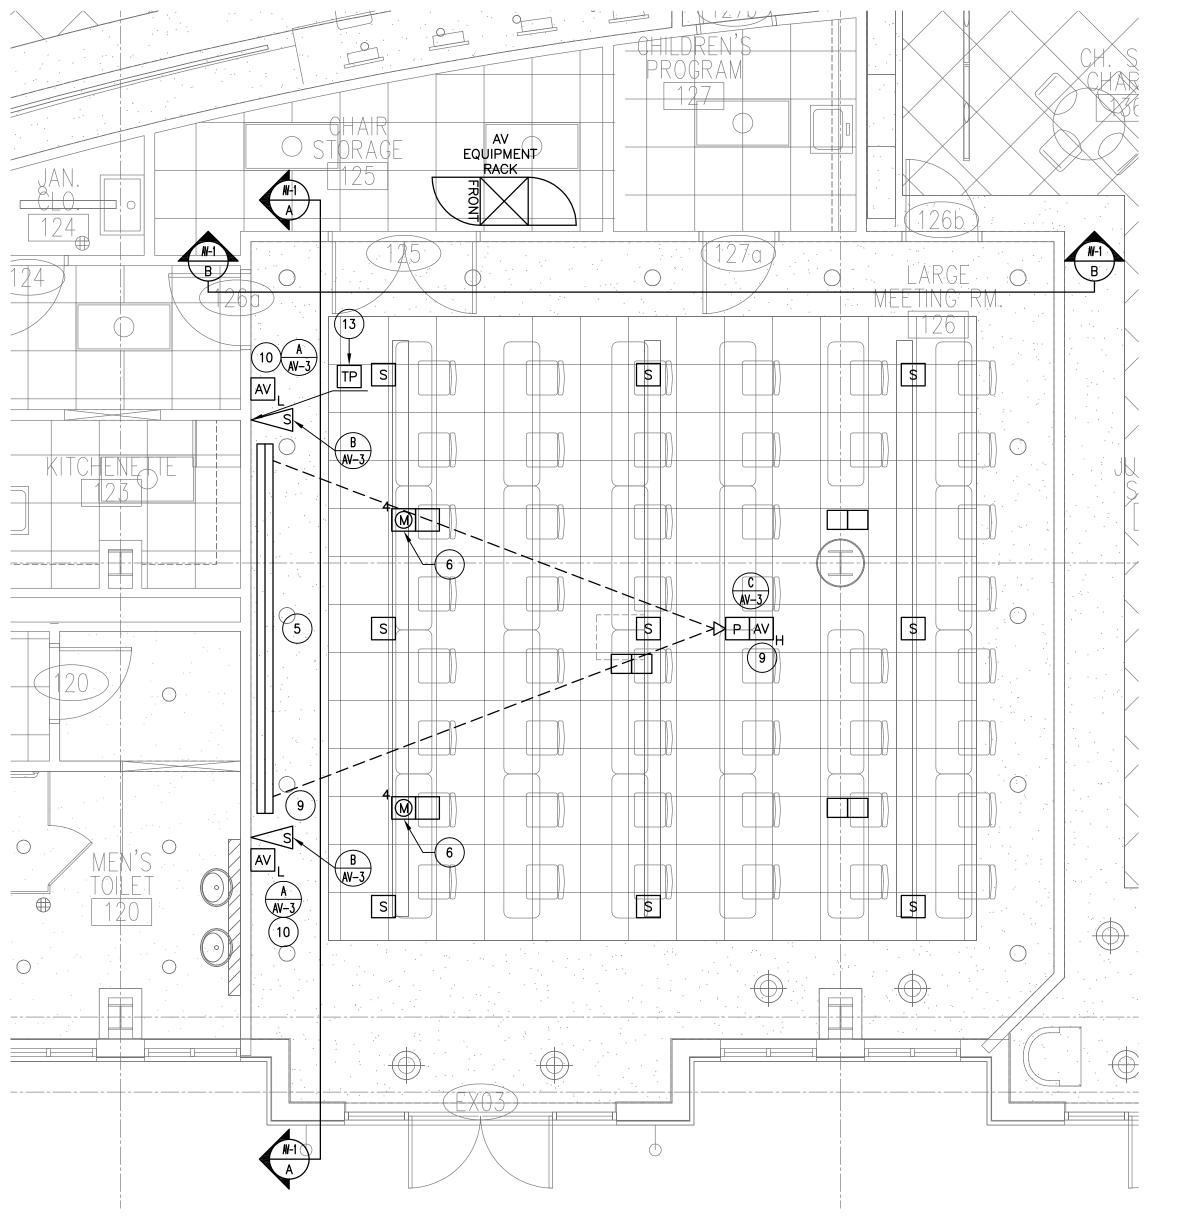


LARGE MEETING ROOM 126 ENLARGED PLAN – AV

SCALE: 1/4" = 1'-0" Loudoun
County
Public Library
Gum Spring
Branch

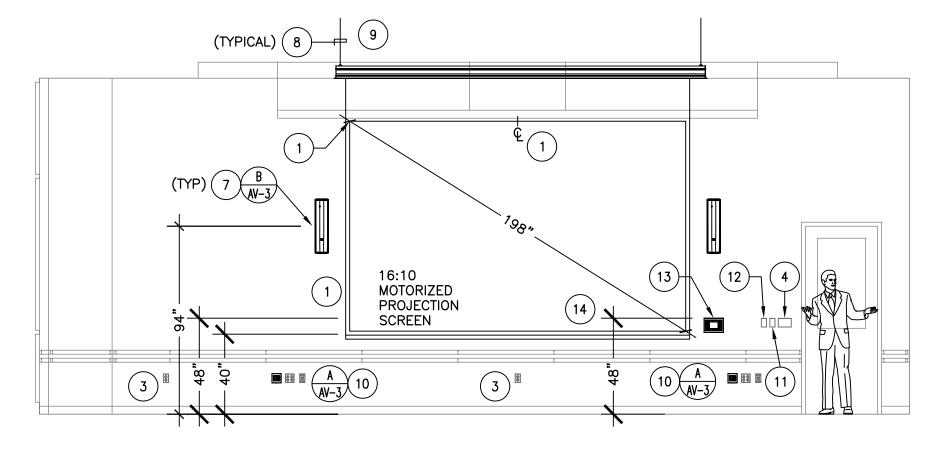



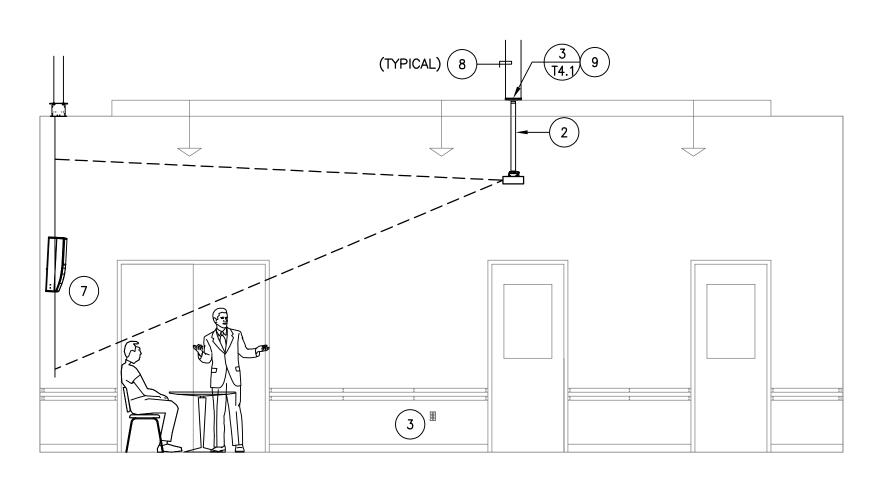

LARGE MEETING ROOM 126

ELEVATION – AV

SCALE: 1/4" = 1'-0"

Sheet Title:

LARGE MEETING ROOM 128 - PLANS AND ELEVATIONS - AUDIO /

Sheet Number:

Drafter: NPD

NOTE:
CONTRACTOR SHALL CHECK &
VERIFY ALL DIMENSIONS &
EXISTING CONDITIONS AT SITE.

Issue Date: 05/01/2012
Project Manager: PMW




Fax 703-691-3316

# COORDINATION WITH ON-SITE ELECTRICAL CONTRACTOR

CONDUIT, PATHWAYS, AND BACKBOXES ARE PROVIDED BY THE ON-SITE ELECTRICAL CONTRACTOR.

BEFORE ROUGH-IN THE AV CONTRACTOR SHALL MEET WITH THE ON-SITE ELECTRICAL CONTRACTOR TO REVIEW, FIELD VERIFY AND ADJUST AS REQUIRED ALL CONDUIT, PATHWAYS, AND BACKBOXES. AV CONTRACTOR SHALL SUBMIT LETTER OF COMPLETION AS A SHOP DRAWING TO THE ENGINEER.

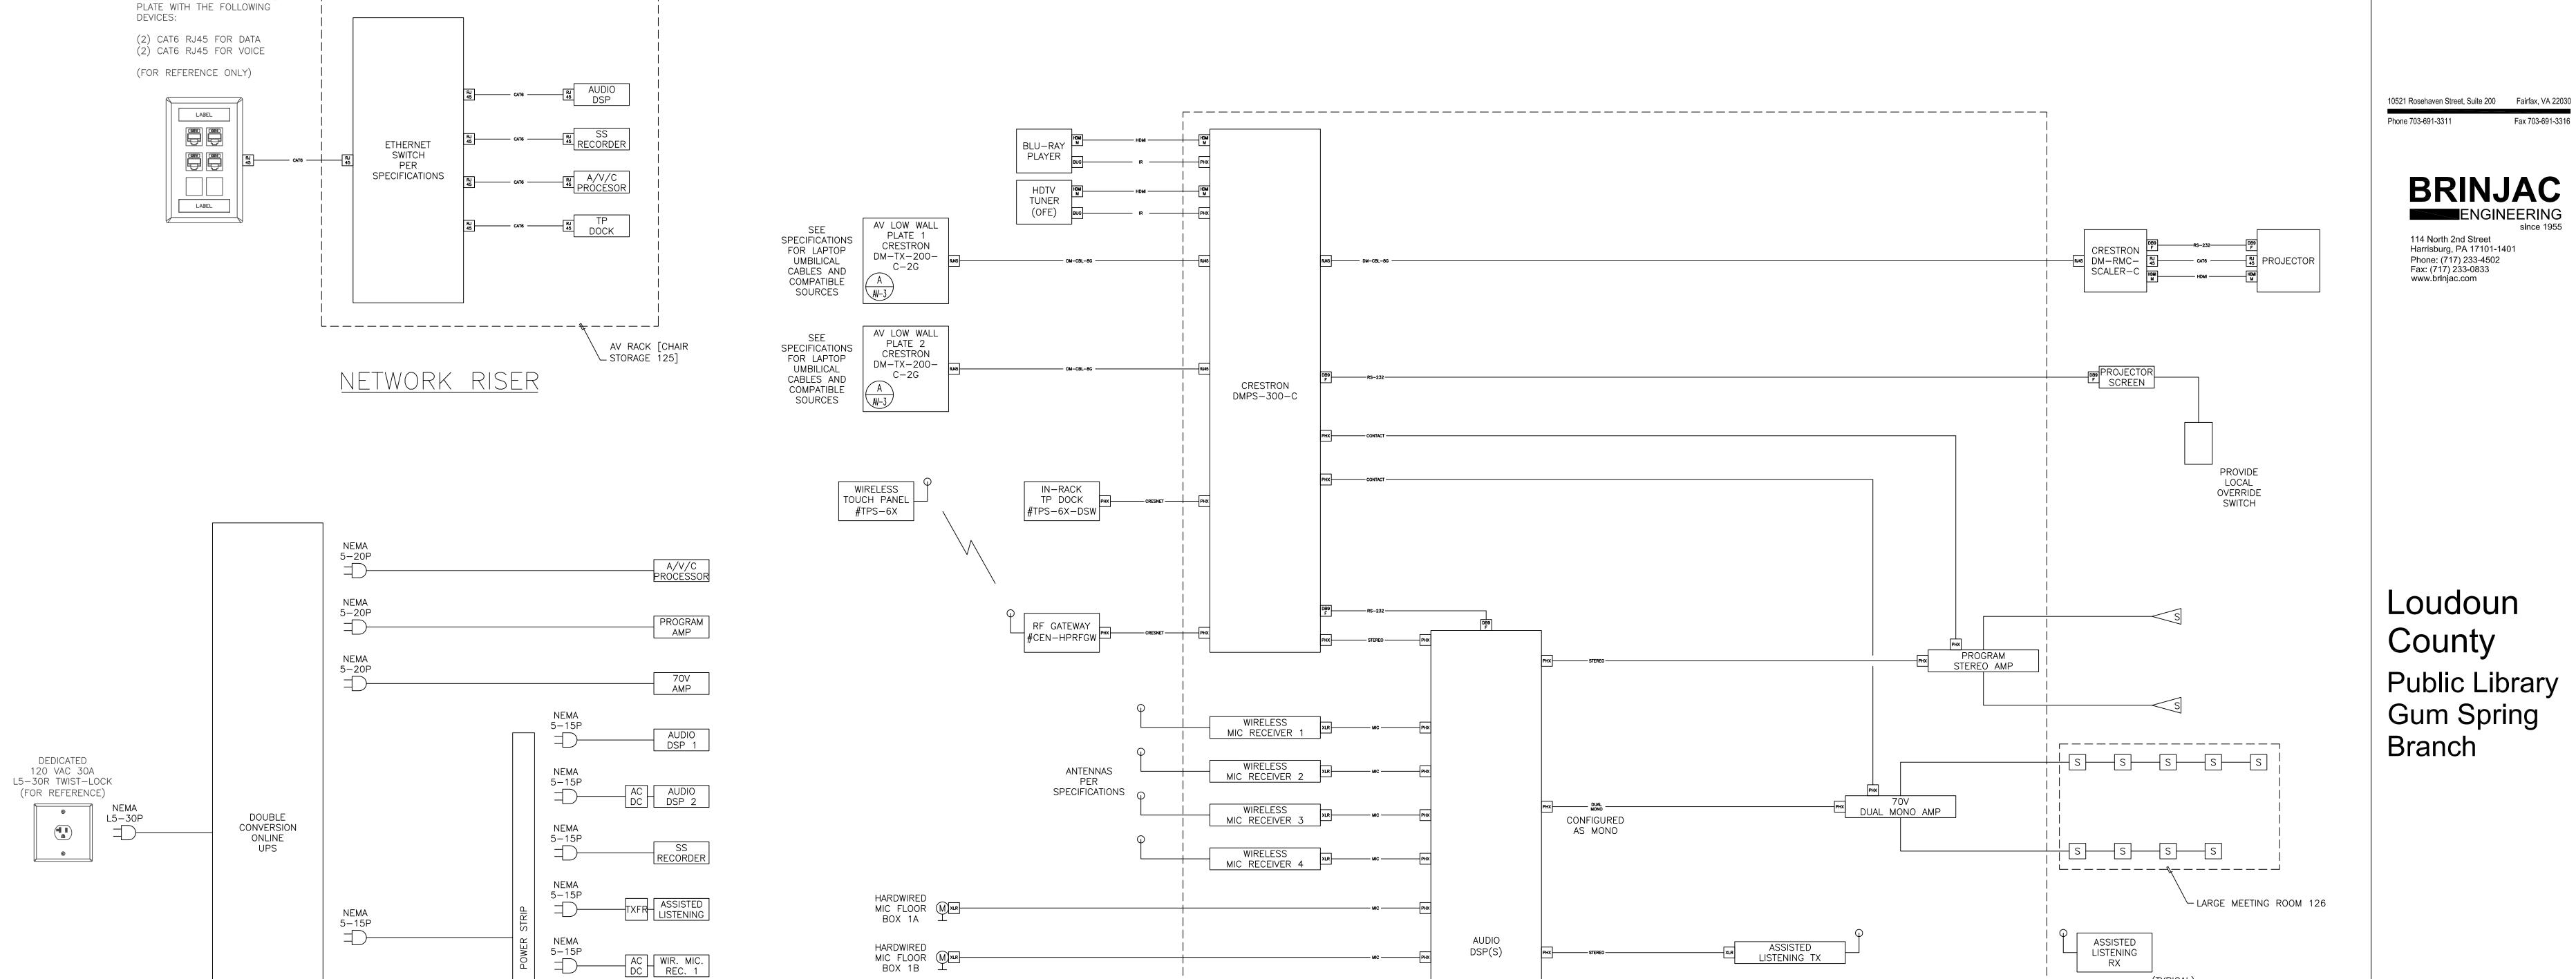

SOLID STATE RECORDING

AV RACK [CHAIR STORAGE 125]

AUDIO/VIDEO/CONTROL RISER

\*\*\*CONTROL VIA ETHERNET\*\*\*

Loudoun County, Virginia

120 VAC 20A 5-20R (FOR REFERENCE) 

C CRESTRON C DM-RMC-SCALER-C NEMA 5-15P PROJECTOR

POWER RISER

\_\_\_\_\_\_\_

NEMA 5-15P

NEMA 5-15P

NEMA 5-15P

AC WIR. MIC. DC REC. 2

AC WIR. MIC. DC REC. 3

AC WIR. MIC. DC REC. 4

TELECOMMUNICATIONS ADAPTER

HARDWIRED
MIC FLOOR MX-BOX 1C \_\_

HARDWIRED
MIC FLOOR MxxBOX 1D

HARDWIRED
MIC FLOOR MXR
BOX 2A

HARDWIRED
MIC FLOOR MXR
BOX 2B

HARDWIRED
MIC FLOOR MXLR
BOX 2C

HARDWIRED
MIC FLOOR MIREBOX 2D \_\_\_

LARGE MEETING ROOM 126 AUDIO / VIDEO - RISERS NO SCALE

LARGE MEETING ROOM

128 - RISERS - AUDIO / VIDEO

Sheet Number:

AV-2

Issue Date: 05/01/2012 Project Manager: PMW Drafter: NPD

CONTRACTOR SHALL CHECK & VERIFY ALL DIMENSIONS & EXISTING CONDITIONS AT SITE.



10521 Rosehaven Street, Suite 200 Fairfax, VA 22030

Fax 703-691-3316

Phone 703-691-3311

114 North 2nd Street

Phone: (717) 233-4502 Fax: (717) 233-0833 www.brinjac.com

Loudoun

Public Library

Gum Spring

County

Branch


Loudoun County, Virginia

Harrisburg, PA 17101-1401


## COORDINATION WITH ON-SITE ELECTRICAL CONTRACTOR

CONDUIT, PATHWAYS, AND BACKBOXES ARE PROVIDED BY THE ON-SITE ELECTRICAL CONTRACTOR.


BEFORE ROUGH—IN THE AV CONTRACTOR SHALL MEET WITH THE ON—SITE ELECTRICAL CONTRACTOR TO REVIEW, FIELD VERIFY AND ADJUST AS REQUIRED ALL CONDUIT, PATHWAYS, AND BACKBOXES. AV CONTRACTOR SHALL SUBMIT LETTER OF COMPLETION AS A SHOP DRAWING TO THE ENGINEER.

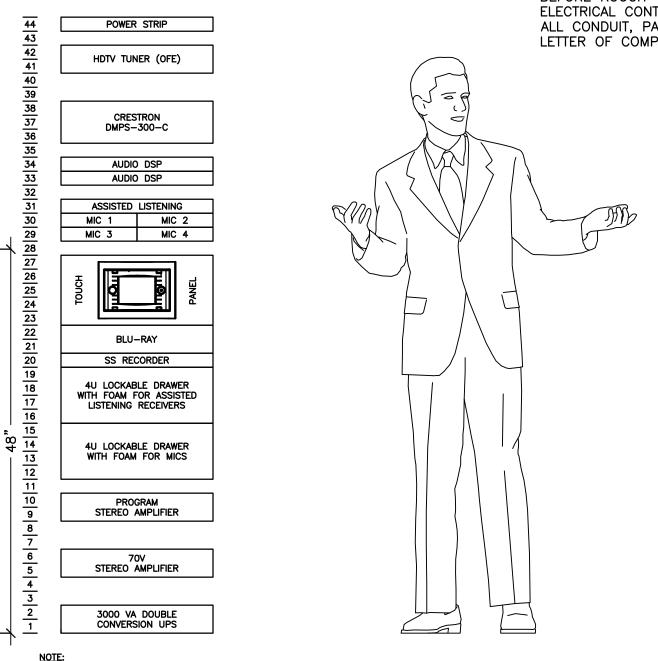


LARGE MEETING ROOM 126 RACK ELEVATION - AUDIO / VIDEO

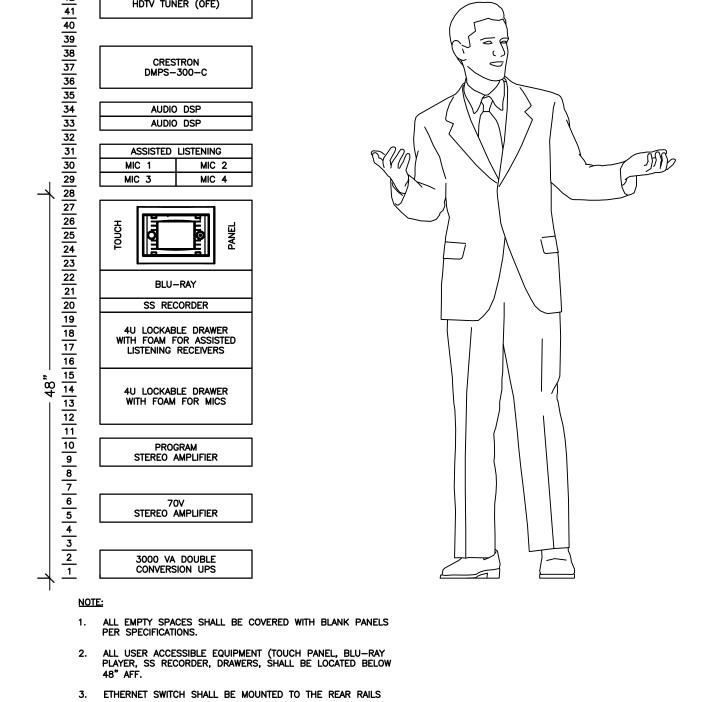

NO SCALE

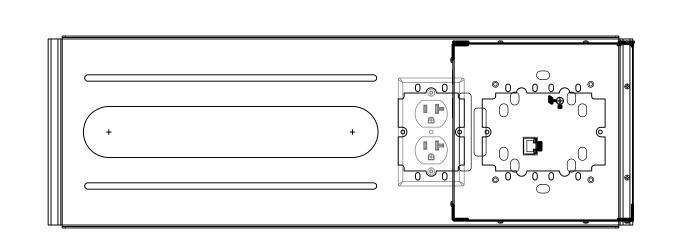

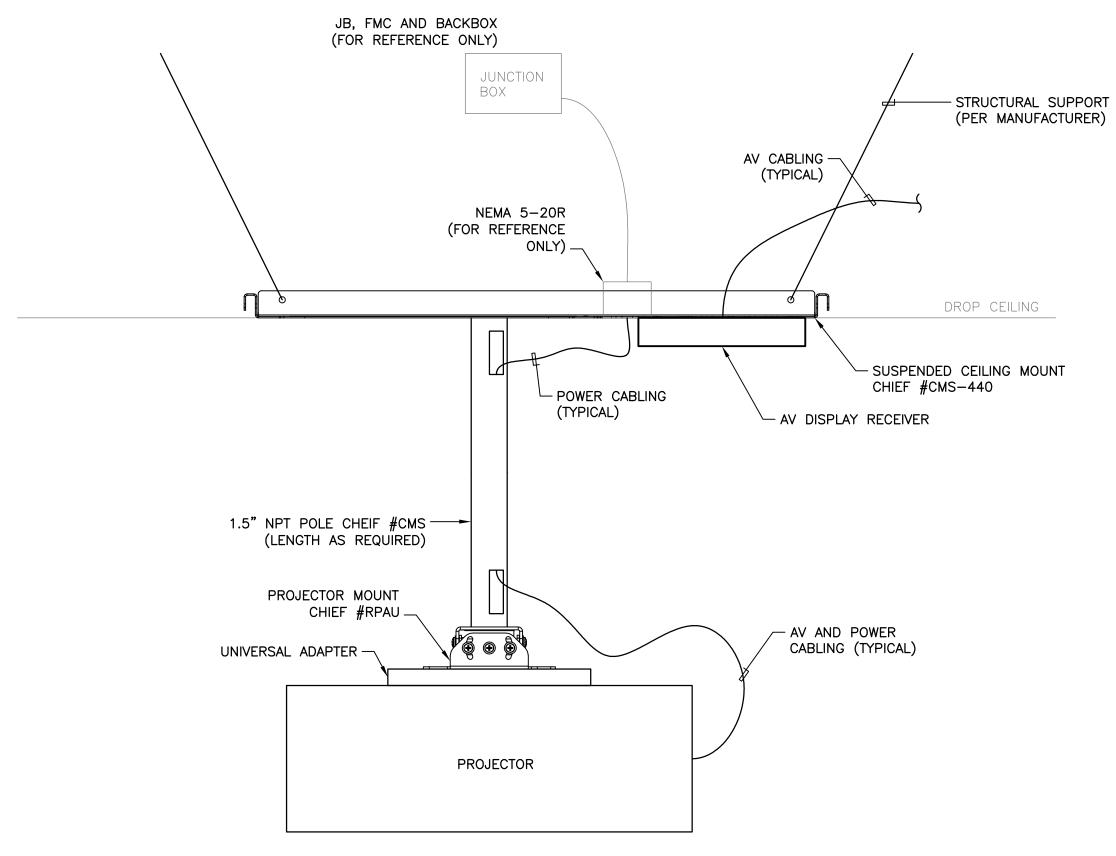


PROJECTOR CEILING MOUNT - DETAIL

LARGE MEETING ROOM 128 - DETAILS - AUDIO / VIDEO


CONTRACTOR SHALL CHECK & VERIFY ALL DIMENSIONS & EXISTING CONDITIONS AT SITE.

AV-3

Issue Date: 05/01/2012 Project Manager: PMW Drafter: NPD

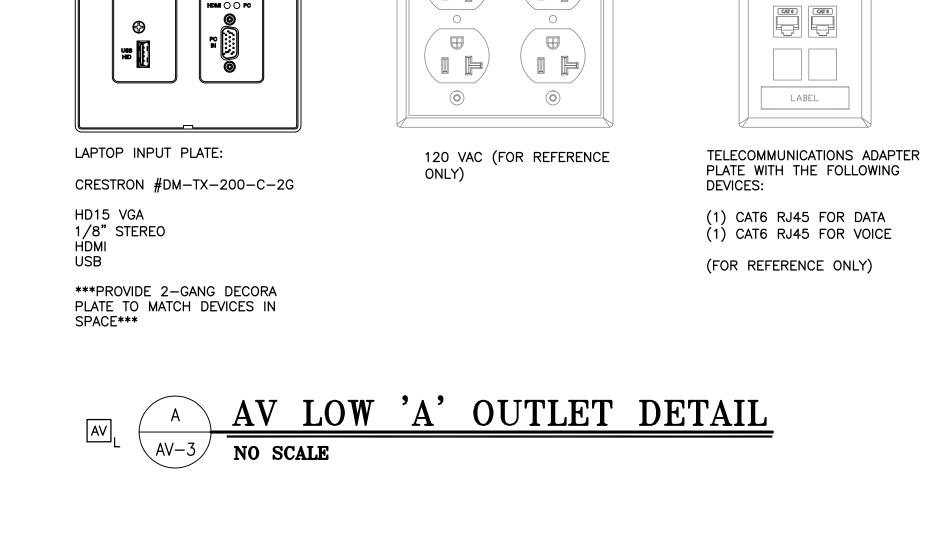

LABEL

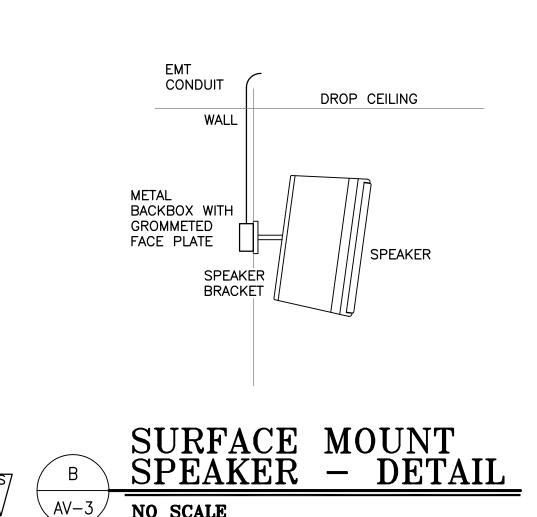





# COORDINATION WITH ON-SITE ELECTRICAL CONTRACTOR

CONDUIT, PATHWAYS, AND BACKBOXES ARE PROVIDED BY THE ON-SITE ELECTRICAL CONTRACTOR.

BEFORE ROUGH—IN THE AV CONTRACTOR SHALL MEET WITH THE ON—SITE ELECTRICAL CONTRACTOR TO REVIEW, FIELD VERIFY AND ADJUST AS REQUIRED ALL CONDUIT, PATHWAYS, AND BACKBOXES. AV CONTRACTOR SHALL SUBMIT LETTER OF COMPLETION AS A SHOP DRAWING TO THE ENGINEER.

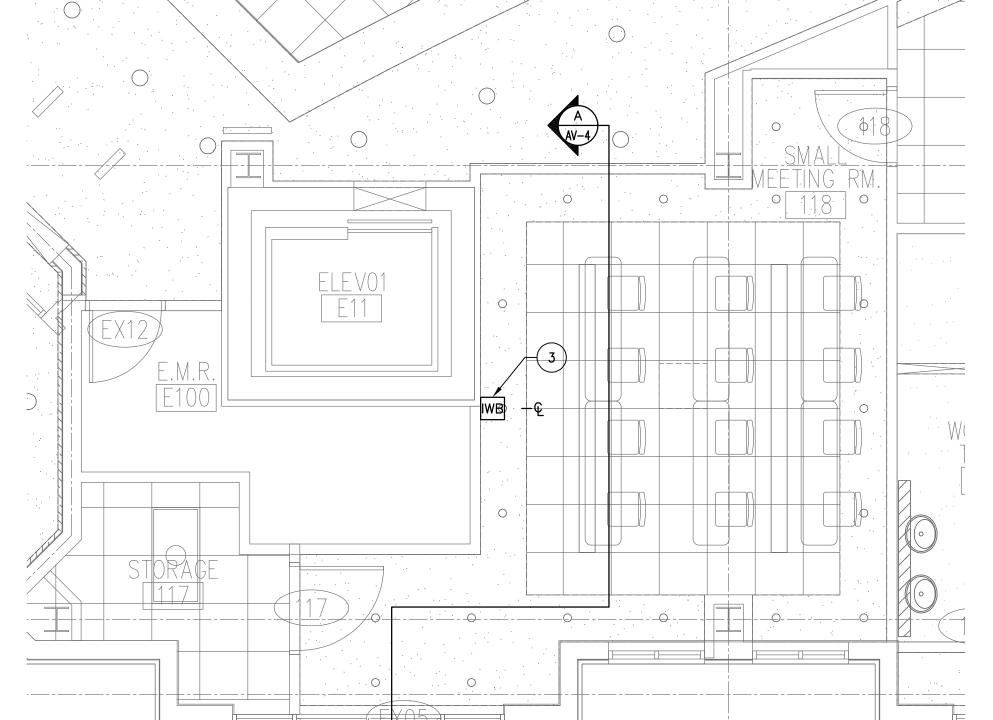

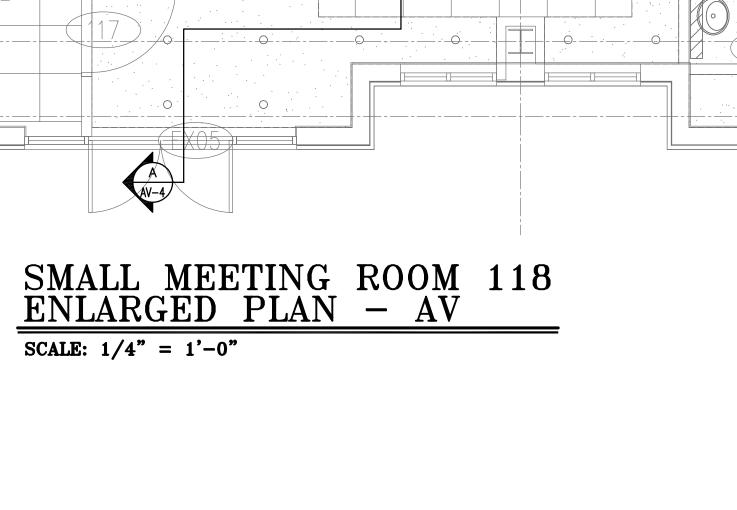



ALL CABLES SHALL BE PLENUM RATED OR RUN IN EMT CONDUIT.

#### **KEYED NOTES:**

1 RECEPTACLE AND TELECOMMUNICATIONS OUTLETS. FOR REFERENCE ONLY.

2 120 VAC QUAD. FOR REFERENCE ONLY 3 PROVIDE WALL MOUNTED INTERACTIVE WHITE BOARD PER THE SPECIFICATIONS. INSTALL PER MANUFACTURERS SPECIFICATIONS.


Phone 703-691-3311

114 North 2nd Street Harrisburg, PA 17101-1401 Phone: (717) 233-4502 Fax: (717) 233-0833 www.brinjac.com

10521 Rosehaven Street, Suite 200 Fairfax, VA 22030

Fax 703-691-3316

Loudoun County Public Library Gum Spring Branch

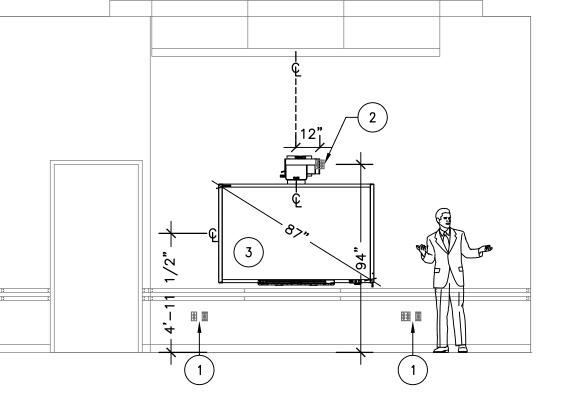


SMALL MEETING ROOM 118 ELEVATION - AV SCALE: 1/4" = 1'-0"

SMALL MEETING ROOM 118 - PLANS AND DETAILS - AUDIO / VIDEO

Sheet Number:

AV-4 CONTRACTOR SHALL CHECK & VERIFY ALL DIMENSIONS & EXISTING CONDITIONS AT SITE.

Issue Date: 05/01/2012 Project Manager: PMW Drafter: NPD

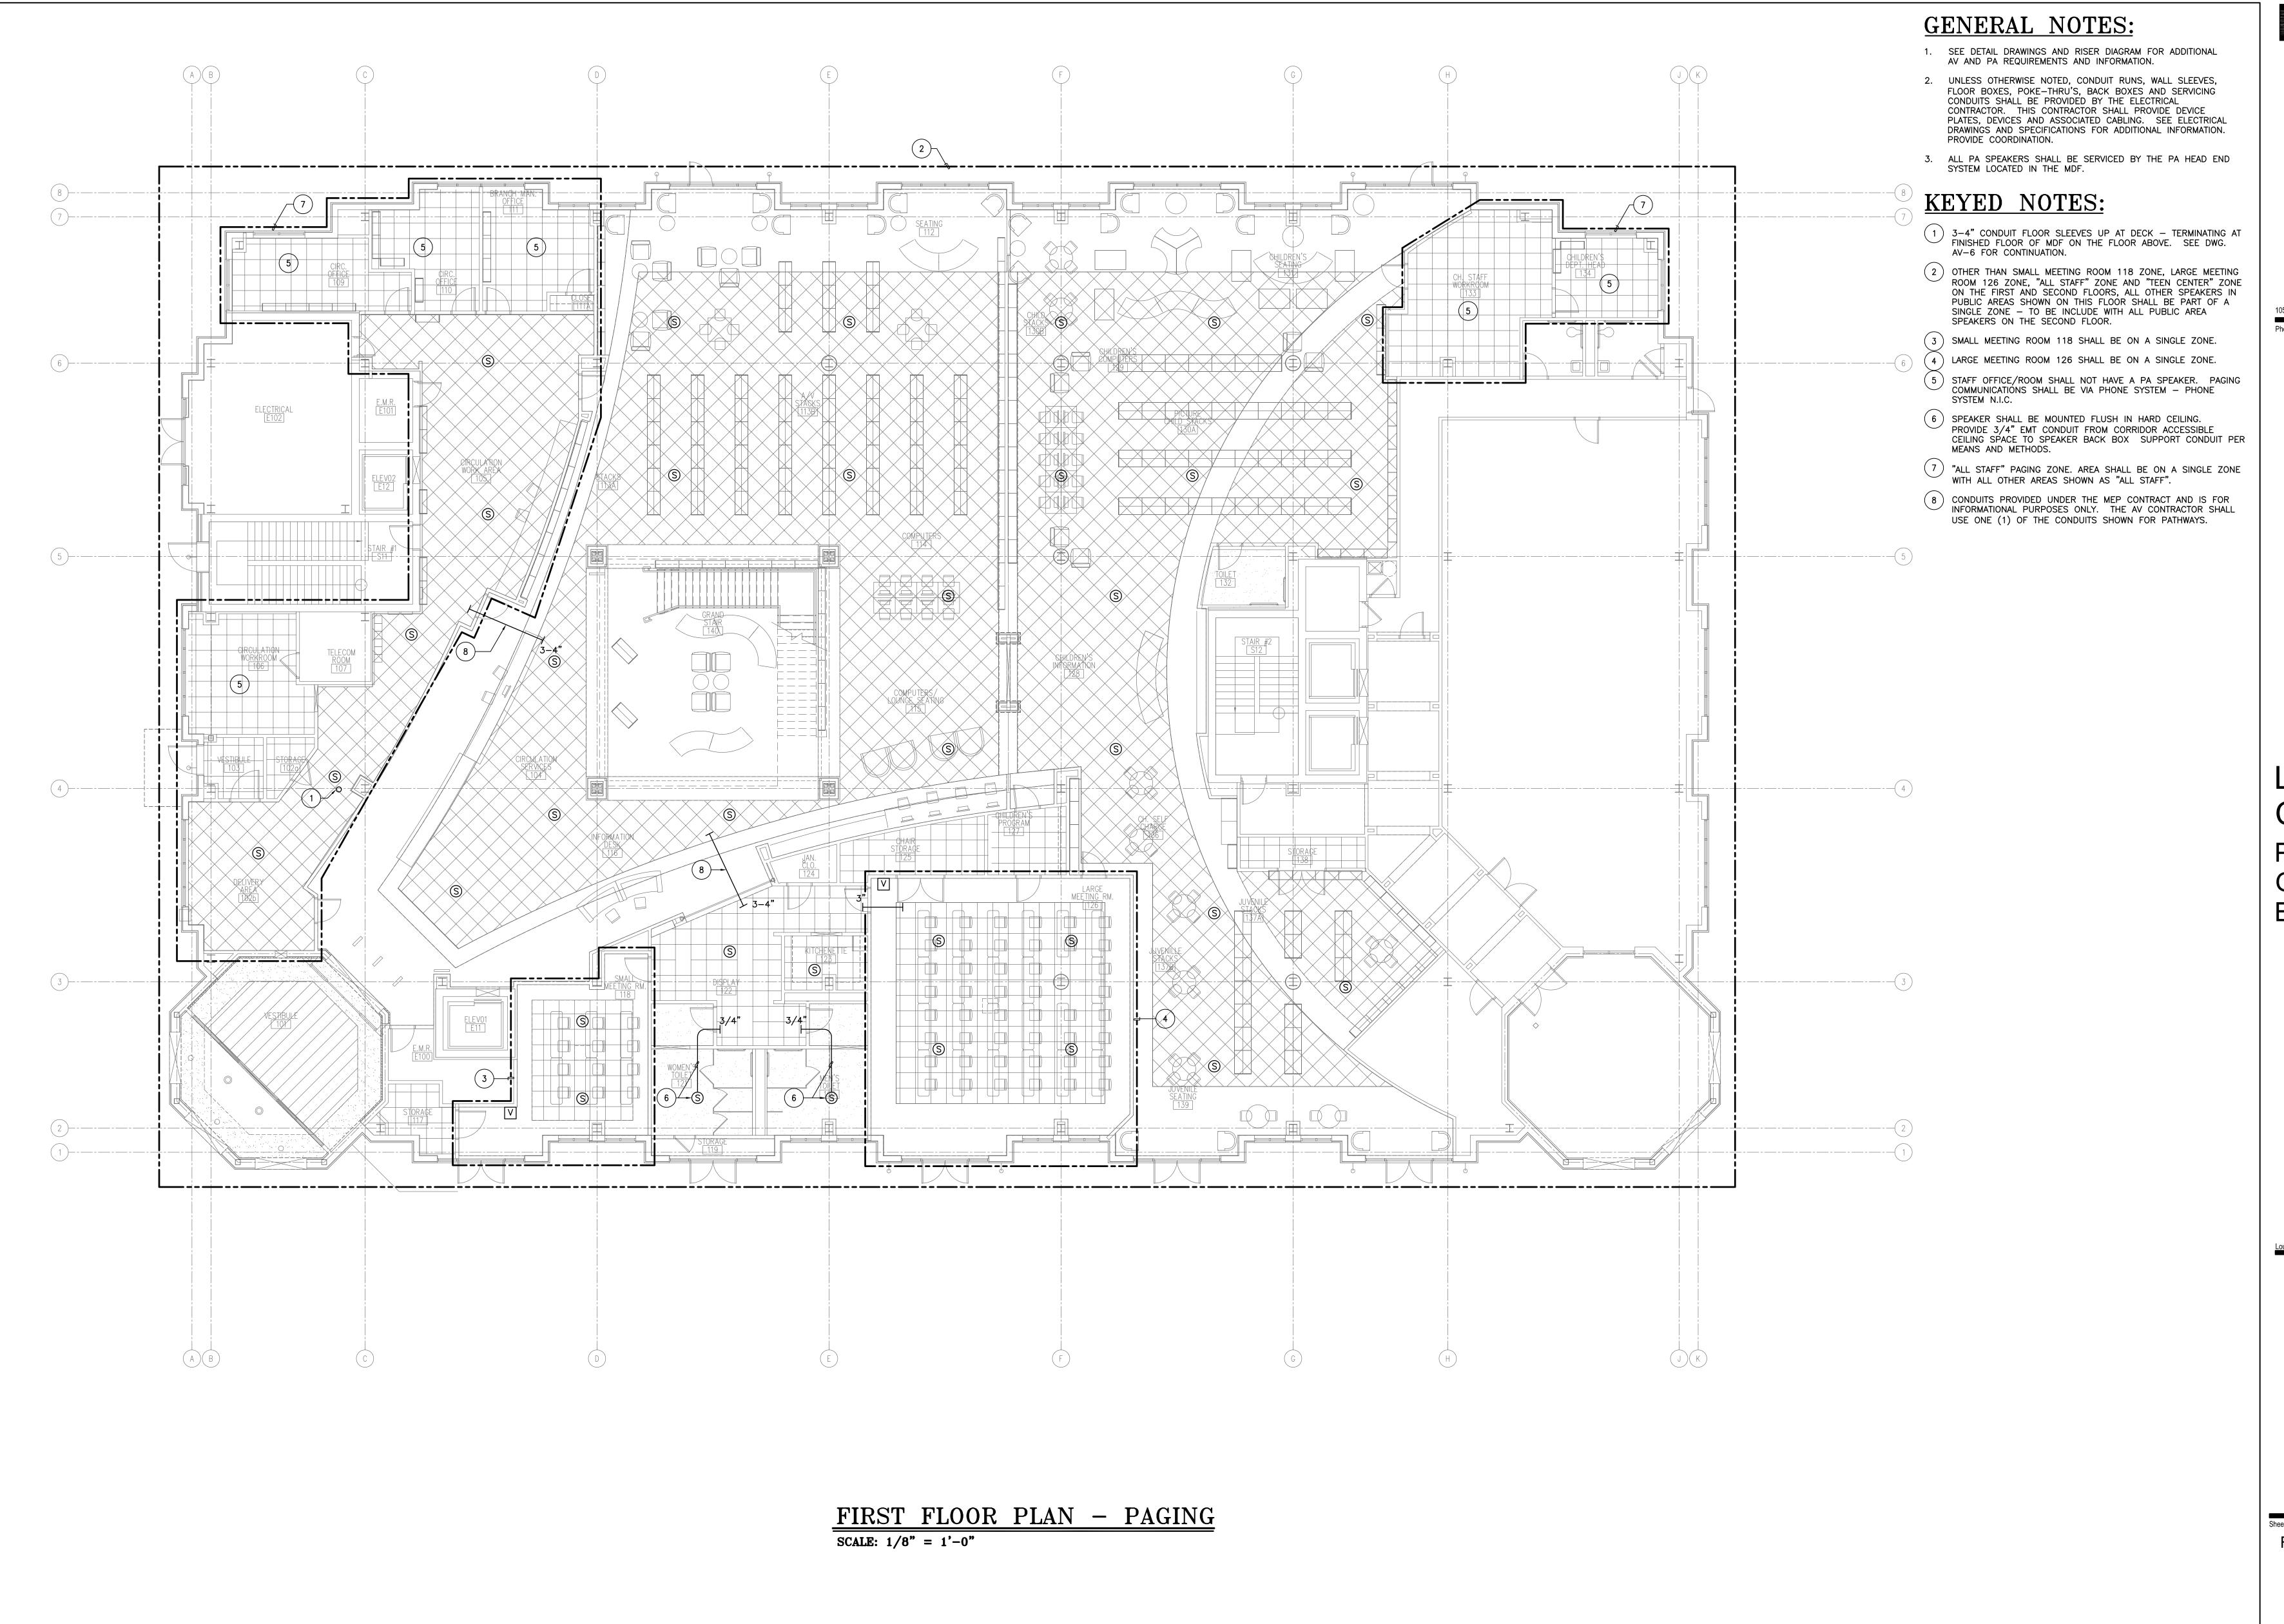

10521 Rosehaven Street, Suite 200 Fairfax, VA 22030 Phone 703-691-3311 Fax 703-691-3316

114 North 2nd Street Harrisburg, PA 17101-1401 Phone: (717) 233-4502 Fax: (717) 233-0833 www.brinjac.com

Loudoun County Public Library Gum Spring Branch

FIRST FLOOR PLAN -**PAGING** 

AV-5 CONTRACTOR SHALL CHECK & VERIFY ALL DIMENSIONS & EXISTING CONDITIONS AT SITE.

Issue Date: 05/01/2012 Project Manager: PMW Drafter: KWW



**SAMAHA** 

10521 Rosehaven Street, Suite 200 Fairfax, VA 22030 Fax 703-691-3316 Phone 703-691-3311

114 North 2nd Street

Harrisburg, PA 17101-1401 Phone: (717) 233-4502 Fax: (717) 233-0833 www.brinjac.com

Loudoun County Public Library Gum Spring Branch

SECOND FLOOR PLAN -**PAGING** 

AV-6 CONTRACTOR SHALL CHECK & VERIFY ALL DIMENSIONS & EXISTING CONDITIONS AT SITE.

Issue Date: 05/01/2012 Project Manager: PMW Drafter: KWW

#### **GENERAL NOTES:**

- 1. SEE FLOOR PLANS FOR SPEAKER LOCATIONS AND ZONING.
- ALL PA SPEAKERS SHALL BE SERVICED BY THE PA HEAD END SYSTEM LOCATED IN THE MDF.



10521 Rosehaven Street, Suite 200 Fairfax, VA 22030 Phone 703-691-3311 Fax 703-691-3316



Loudoun County Public Library Gum Spring Branch


Loudoun County, Virginia

PA RISER DIAGRAM & **DETAILS - PAGING** 

Drafter: KWW

AV-7 Issue Date: 05/01/2012 Project Manager: PMW

CONTRACTOR SHALL CHECK & VERIFY ALL DIMENSIONS & EXISTING CONDITIONS AT SITE.

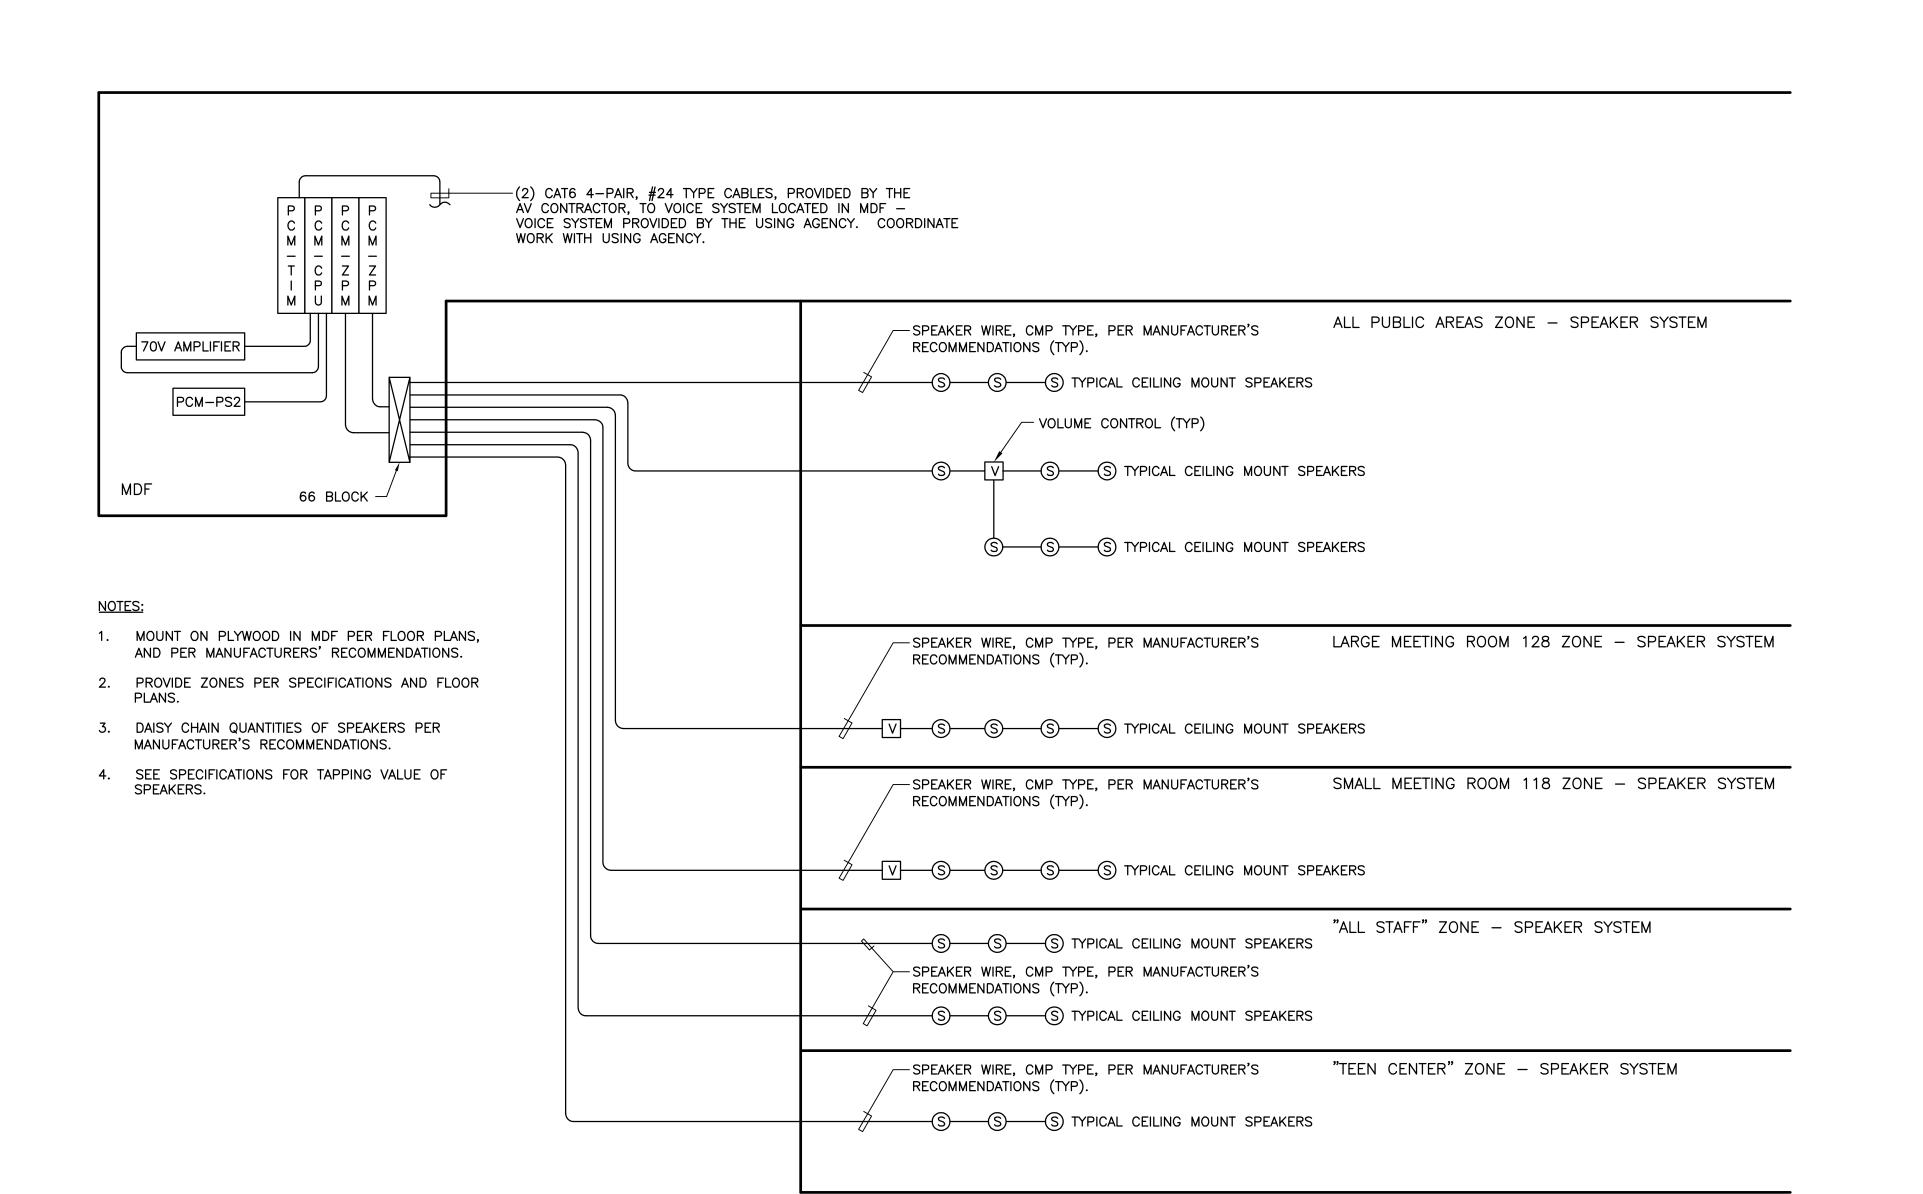

### MASTER PA RISER DIAGRAM

NO SCALE